District of Saanich Current Planning 770 Vernon Ave. Victoria BC V8X 2W7

**t.** 250-475-5471 **f.** 250-475-5430 saanich.ca



May 30, 2025 Sent via email

Dear Mount View Colquitz Community Association:

Re: Application for Development:

Applicant: M'AKOLA DEVELOPMENT SERVICES

Site Address: 3656 RAYMOND ST S

Legal: LOT 1 SECTION 14 VICTORIA DISTRICT PLAN EPP140768

Folder No.: DPR01089

Description: TO REZONE FROM RD1/P1 ZONE TO CD ZONE TO CONSTRUCT

A SIX STOREY MIXED USE DEVELOPMENT WITH 55 PURPOSE

**BUILT RENTAL UNITS** 

The District of Saanich has received an application for a site within your Community Association area. The Planning Department is referring the proposed plans and relevant information to your Community Association for review and comment. Please note that requested variances may be subject to change based on the Planners detailed review of the file.

In a written letter or email to <a href="mailto:planning@saanich.ca">planning@saanich.ca</a>, please provide your comments and indicate if your Community Association:

Support the application Object to the application Have no position on the application
Additional Comments:

We would appreciate receiving your comments within one month of this letter so that they can be included in the package that will be forwarded to Council. If you cannot meet this timeframe, please email or call our office to indicate if and when you might be able to respond to the referral.

If you require further information about the proposed development please contact THOMAS KEMPSTER Planner at 3404.

It is suggested that you periodically check our website, <u>www.saanich.ca</u> *Permit and Development Tracker* as any revised site plans for this application will be posted there.

Sincerely,

Planner


 District of Saanich Current Planning 770 Vernon Ave. Victoria BC V8X 2W7

t. 250-475-5471 f. 250-475-5430 saanich.ca



### PRIORITY REFERRAL FORM

Application No.	Referral	date: M	lay 28, 2025		
			June 18, 2025		
□ DPR - 01089	File Mana	ger: THO	MAS KEMPST	ER	
□ DPA –			A DEVELOPM		CES
□ DVP –					
□ REZ - 00796	Owner: METIS PROVINCIAL COUNCIL OF BRITISH COLUMBIA				
□ TUP -					
External Referrals:			RAYMOND ST		T DI ANI
	EPP14076		N 14 VICTOR	IA DISTRIC	IPLAN
■ Ministry of Transportation  ☐ Observatory (5 km radius)	Current Z		1/P1		
■ BC Transit		Zone: Cl	the state of the s		
School District # 61		OCP designation		bourhood/Ir	etitutional
☐ School District # 63		OCP amen		es 🗆 No	Siliutional
■ Mount View Colquitz Community Assc.	DP Area:		ament.	es LINU	
☐ Peninsula Ag Advisory Comm (PAAC)	Dr Alea.	CAILL			
D 1 chinidate / 1g / tavicery commit (1 / 1/6)					
Internal Referrals:	Land Con	nments	SDPA	Yes □	No ■
■ Plan Check (LAP)	Heritage Yes □ No ■				
■ Environment			No ■		
■ Parks			FIDP	Yes □	No =
■ Development Services	Sign Post	ting Require	ed: ■Yes □		
■ Housing		escription:	<b>学的,正常只要</b> 特		
☐ Planning Subdivision Tech	TO REZONE FROM RD1/P1 ZONE TO CD ZONE TO				
☐ Police			STOREY MIXE		ELOPMENT
☐ Committee	WITH 55 I	PURPOSE E	BUILT RENTAL	LUNITS	
☐ Neighbouring Jurisdictions		ALLES MAN			
	Project De	scription Re	viewed/Update	d 🗆 Planı	ners Initials
Departments and Agencies: Please complete. If no response is rece that you have no objections. Send e-mail Name:	ived by the il response	above "Co s to plannin	mments due l ng@saanich.c	by" date, it i a.	is understood
Title:	Phone:				
Date:	E-mail:				
Response:  ☐ Support – see comments below ☐ Object – see comments below ☐ No position – see comments below Comments: Add additional page(s) if necess	sary				

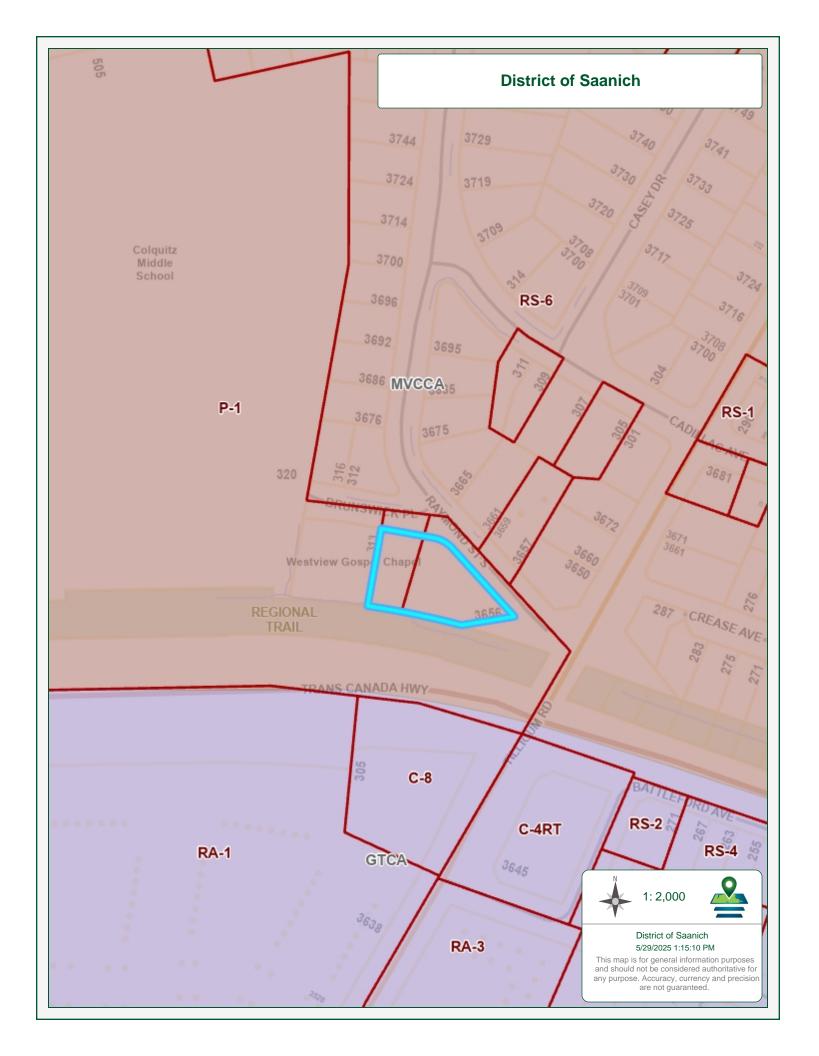

Copyright reserved. This design and drawing is the exclusive property of Public Architecture + Design Inc. and cannot be used for any purpose without the written consent of the Architect. This drawing is not to be used for construction until issued for that purpose by the Architect. Prior to commencement of the Work the Contractor shall verify all dimensions, datums and levels to identify any errors and omissions; ascertain any discrepancies between this drawing and the full Contract Documents; and, bring these items to the attention of the Architect for clarification.

ISSUES + REVISIONS
NO DATE DESCRIPTION A 02 Apr 2024 Draft BCH IHF application
B 30 Apr 2024 BCH IHF application
C 16 May 2025 DP/ Rez application

#### Legend

Service right of way

Right of way

Setback line

Property line Existing PL between sites

Refer to Landscape Existing trees


Proposed trees

Bike stalls

#### **Abbreviations** EG - Existing grade

**Note** Refer to Survey on sheet A0.03 for additional information on site dimensions and areas.

0

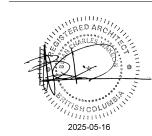

# public

1495 FRANCES STREET VANCOUVER BC V5L 1Z1 TEL 604 738 4323 PUBLICARCHITECTURE.CA

## MNBC Housing and Child Care

3656 Raymond Street South 307 Brunswick PL

**PROJECT CODE** 2301 SCALE As indicated

Site plan 1:200 1/8


Site plan

A0.05



Copyright reserved. This design and drawing is the exclusive property of Public Architecture + Design Inc. and cannot be used for any purpose without the written consent of the Architect. This drawing is not to be used for construction until issued for that purpose by the Architect. Prior to commencement of the Work the Contractor shall verify all dimensions, datums and levels to identify any errors and omissions; ascertain any discrepancies between this drawing and the full Contract Documents; and, bring these items to the attention of the Architect for



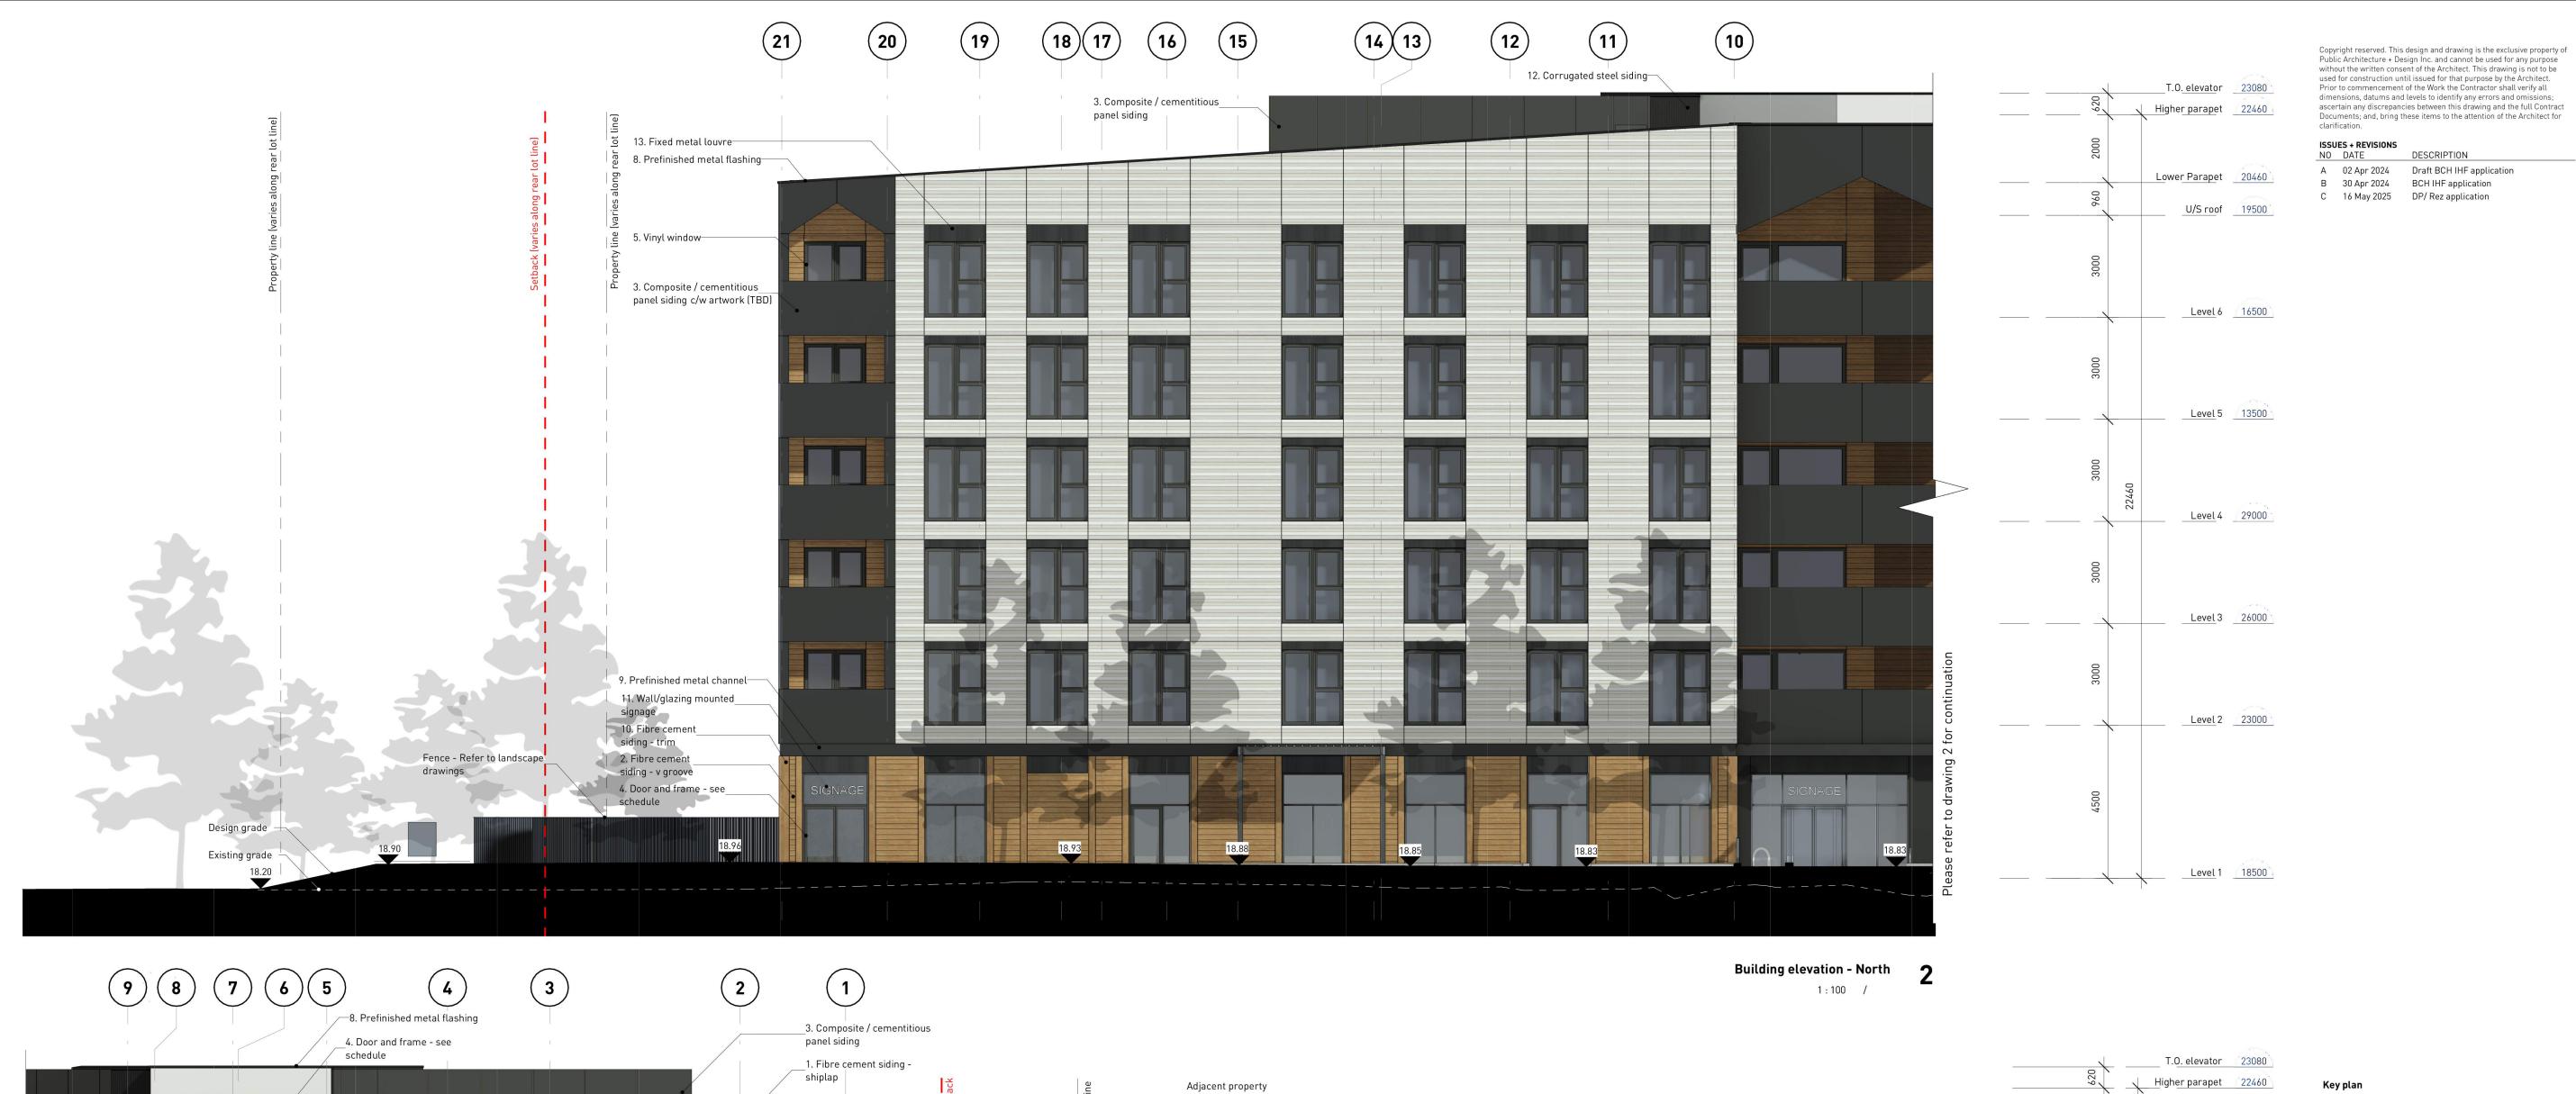

\_3. Composite / cementitious

\_\_3. Composite / cementitious panel siding c/w artwork (TBD)

3. Composite / cementitious

∕–9. Prefinished metal channel

panel siding

\_\_10. Fibre cement

siding - trim

\_2. Fibre cement siding - v groove


\_\_14. Aluminum window see schedule

—6. Concrete faced insulation

—7. Concrete retaining wall

Design gradeExisting grade

11. Wall/glazing mounted\_\_ signage panel siding

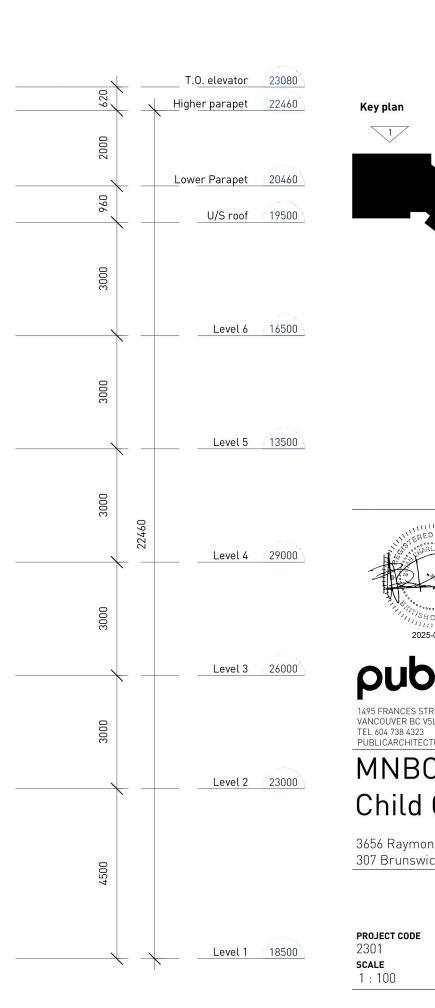

**Building elevation - Northwest** 

Dublic

1495 FRANCES STREET
VANCOUVER BC V5L 1Z1
TEL 604 738 4323
PUBLICARCHITECTURE.CA

MNBC Housing and
Child Care

3656 Raymond Street South
307 Brunswick PL

Building elevation


A2.02

## **MNBC**

# 3656 Raymond Street & 307 Brunswick Place

Saanich, BC



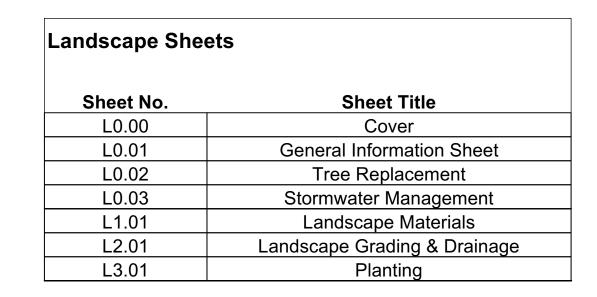


# RECEIVED

MAY 20, 2025

PLANNING DEPT.
DISTRICT OF SAANICH



NOT FOR CONSTRUCTION

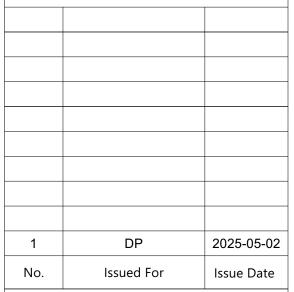



client

MNBC Saanich Development

roject

3656 RAYMOND STREET & 307 BRUNSWICK PLACE

Saanich, BC

Cover

sheet title

project no.		124.06
scale	1: 250	@ 24"x36"
drawn by		MDI
checked by		SM
sheet no.		

L0.00

#### **GENERAL NOTES**

- 1. Work performed shall comply with the following: a) These General Notes, and Construction Documents and Specifications; b) Canadian Landscape Standards, Current Edition (CLS-CE); and c) All applicable local, provincial, and federal codes, ordinances, and regulations.
- 2. Contractor shall be responsible for verifying all existing site conditions including location of all property lines, existing structures, utilities, and buried infrastructure. Verify all field conditions prior to commencing work.
- 3. Contractor is responsible for determining means and methods for construction. These drawings may indicate a limit of proposed improvements or limit of work for the delineation of expected extents of disturbance. Should limits of disturbance exceed boundaries defined in drawings, contractor shall contact Landscape Architect for resolution.
- 4. Contractor is responsible for repairing all work disturbed by construction outside of limit lines defined on drawings or through their means and methods to a condition better than or equal to the existing conditions prior to commencement of construction at no additional cost to the owner.
- 5. Contractor is responsible for maintaining a complete up-to-date set of drawings and specifications at the construction site and ensuring the documents are readily available for review by the Landscape
- Architect and governing agency. 6. Contractor is responsible for coordination of all designs, drawings, specifications and other documents or publications upon which construction is based. Any discrepencies with the drawings and/or specifications and site conditions shall be brought to the attention of the Landscape Architect, prior to
- 7. The drawings and specifications are complementary to one another and implied to correspond with one another. Any discrepencies should be brought to the attention of the Landscape Architect for resolution immediately.
- 8. General Contractor and/or sub-contractors are responsible for all costs related to production and submission to consultant of all landscape as-built information including irrigation.

#### TREE RETENTION AND REMOVAL NOTES

- 1. Tree protection fencing, for existing trees, to be installed prior to commencement of all site work. Refer to Arborist's plans for location of tree protection fencing, and protection fencing detail.
- 2. Refer to arborist's report for detailed information for existing tree resources.

#### SITE GRADING AND DRAINAGE NOTES

All elevations are in meters.

proceeding with construction.

- 2. Refer to Architectural plans, sections and elevations for top of slab elevations. Slab elevations indicated on Landscape drawings are for reference only. Report any discrepancies to consultant for review and response
- 3. All road, public walkway and vehicular drive aisles and parking area elevations indicated on the Landscape drawings are for reference only. Refer to Civil Engineering drawings. Report any discrepancies to consultant for review and response.
- 4. Confirm all existing grades prior to contruction. Report any discrepancies to consultant for review and
- Unless otherwise noted provide a minimum slope of 2% on all hard and soft Landscape areas to ensure positive drainage away from buildings, to rain gardens, or to drainage devices.
- 6. All landscape areas shall not exceed a maximum slope of 3:1 in all instances.
- 7. Upon discovery, contractor to refrain from blasting rock to meet landscape subgrades. Contractor to
- contact Landscape Architect on how to proceed in each instance.

#### <u>IRRIGATION NOTES</u>

- 1. Contractor to provide irrigation system for all planters to current IIABC Standards and Contract Specifications.
- 2. All specified work to meet the project specifications, and all standards or specifications established in the lastest edition of the Canadian Landscape Standard and IIABC standards.
- 3. Design/build drawings for detailed irrigation plan to be submitted to Contract Administrator in PDF and .dwg formats at least two weeks prior to commencement of irrigation installation
- 4. Utilities Contractor to verify location of all on-site utilities, prior to construction. Restoration of damaged utilities shall be made at the contractor's expense, to the satisfaction of the owner's representatives.

#### 5. Refer to electrical drawings for electrical service.

- 6. Controller and backflow prevention device to be located in Mechanical Room, unless otherwise noted. Refer to Mechanical drawings for size and location of irrigation service.
- Contractor to verify pressure and flow prior to installation of irrigation and notify owner's representative in writing if such data adversely affects the operation of the system.
- 8. Sleeves shall be installed at the necessary depths, prior to pavement construction. Sleeving shall extend 300 mm from edge of paving into planting area, and shall have ends marked above grade unless otherwise shown.
- Contractor to field fit irrigation system around existing trees, to limit disturbance to root systems. 10. At various milestones during construction, inspection and testing of components will be required to ensure that the performance of irrigation system meets standards and specifications. Contractor to provide equipment and personnel necessary for performance of inspections and tests. Conduct all inspections and tests in the presence of the contract administrator. Keep work uncovered and
- accessible until successful completeition of inspection or test. 11. Over spray onto hardscape areas to be minimized. Use drip irrigation within small planting areas to avoid overspray.
- 12. Trees within shrub or rain garden areas to be irrigated with spray heads.
- 13. Trees in Plaza in hard pavement (soil cells below) to recieve temporary irrigation system around root collar and permanent drip irrigation system

#### **GROWING MEDIUM NOTES**

- 1. Refer to Landscape Specifications for growing medium properties by soil type.
- Advise Contract Administrator of sources of growing medium to be utilized 14 days in advance of
- 3. Growing medium properties and handling shall meet CLS-CE (see Section 6 CLS-CE). 4. Contractor is responsible for soil analysis and amendment requirements to supply suitable growing
- medium, as specified by testing agency. Soil analysis and amendment costs shall be included in the
- 5. Submit to the Landscape Architect a copy of the soil analysis report from Pacific Soil Analysis Inc. 5-11720 Voyageur Way, Richmond, BC, V6X 3G9. p. 604- 273-8226. The analysis shall be of tests done on the proposed growing medium from stratified samples taken from the supply source. Costs of the initial and all subsequent tests to ensure compliance with the specifications shall be borne by the Contractor.
- 6. Contract Administrator will collect sample of growing medium in place and determine acceptance of material, depth of growing medium and finish grading. Approval of growing medium material subject to soil testing and analysis. Planting is not to occur until finished grades have been approved by Contract Administrator.

#### **SITE LAYOUT NOTES**

- 1. Provide layout of all work for approval by Contract Administrator prior to proceeding with work. Requests for site review as required 48 hours in advance of performing any work, unless otherwise
- 2. Layout and verify dimensions prior to construction. Bring discrepancies to the attention of the Contract Administrator.
- 3. Written dimensions take precedence over scale. Do not scale drawings.
- 4. All plan dimensions in metres and all detail dimensions in millimetres, unless otherwise noted.
- 5. Where dimensions are called as 'equal' or 'eq', space referenced items equally, measured to centre

### **GENERAL PLANTING NOTES**

- 1. Plant quantities on Plans shall take precedence over plant list quantities.
- 2. Provide layout of all work for approval by Contract Administrator prior to proceeding with work. 3. Plant material, installation and maintenance to conform to the current edition of the Canadian
- Landscape Standard. 4. Plant quantities and species may change between issuance of DP and Construction due to plant availability and design changes. Substitutions to be approved by Landscape Architect.

#### **ON-SLAB TREE PLANTING NOTES**

- 1. For on-slab landscape, a root barrier will be installed to protect exposed water proof membranes. A dimple board (drain mat) will be installed over the root barrier.
- 2. Parkade walls and foundation walls will be protected with a dimple board (drain mat) to convey water to the perimeter drain and protect wall from roots.
- 3. A root barrier will be installed between the tree roots and perimeter drain, to minimize tree root interference with the drain, where the follow conditions exist in on-grade planting areas: a)where trees less than 8m tall are located closer than 2m from a parkade or foundation wall; b) where trees more than 8m tall are located closer than 3m from a parkade or foundation wall; and c) where perimeter
- drains are less than 2m deep. Growing medium depth on slab to conform to Canadian Landscape Standards.

#### **BOULEVARD PLANTING NOTES**

- 1. Boulevard trees have been placed to avoid existing and proposed infrastructure. Trees planted within 1m of an existing underground municipal service will have a root barrier installed between the root ball and the existing infrastructure.
- 2. Boulevard trees will be place a minimum of 1.5m from an above ground municipal service such as fire hydrant, streetlight or driveway.
- 3. Boulevard tree species have been picked from the municipality's list of recommended boulevard trees or have been selected due their site-adapted qualities. Final selection of boulevard trees to be
- determined through consultation with municipal parks staff. 4. Irrigation to be installed as per Municipal Specifications, for all boulevard planting areas (unless otherwise indicated).
- 5. Design/build drawings for boulevard irrigation to be submitted to Contract Administrator in PDF and .dwg formats, at least two weeks prior to commencement of irrigation installation and will be reviewed
- 6. Refer to Civil drawings for location of boulevard irrigation point of connection. Separate water meter and timer/controller, to be provided at point of connection. Timer/controller for boulevard areas must be readily accessible to municipal staff.

Boulevard irrigation to be inspected as per municipal specification by municipal staff. Boulevard tree

irrigation system will be maintained and operated by municipality, after it is inspected and approved by 8. Soil volume for boulevard trees to be as follows: 8 cu. m. for small trees, 12 cu. m. for medium trees,

#### PAVING NOTES

- 1. Final concrete control joint layout to be confirmed by Landscape Architect prior to installation. Control joints to logically align with edges, corners, and intersections of Landscape and Architectural elements and/or as indicated on plan. Contractor to obtain layout approval by Landscape Architect prior to installation. Contractor to pour concrete pavement in alternating panels as required to achieve control
- joint design and to prevent cracking. 2. Cast in place concrete areas that are subject to vechicular loading shall be structurally reinforced for applicable vehicular loading requirements. See Structural Engineering drawings.

#### WARRANTY AND MAINTENANCE NOTES

and 16 cu. m. for large trees.

- Contractor is responsible for Maintenance from installation to Acceptance of the work by the Contract Administrator.
- 2. Refer to Landscape Specifications for Maintenance Period following Acceptance.

Landscape Standards, and the Contract Specifications

3. Landscape installation to carry a 1-year warranty from date of acceptance. This warranty is based on adequate maintenance by the Owner after Acceptance, as determined by the Landscape Architect. The Contractor will not be responsible for plant loss or damage to other products by causes out of the Contractor's control, such as vandalism, "acts of God", "excessive wear and tear", or abuse.

METRE

ΑT

- 4. Contractor is responsible for plant damage, failure and death due to poor delivery, storage and handling, and all other installation related aspects up until the End of Warranty period.
- 5. Plant material, installation and maintenance to conform with the current edition of the Canadian

## LIST OF ABBREVIATIONS

APPROX	APPROXIMATE	IVI MAN	
ARCH	ARCHITECT	MAX	MAXIMUM
AVG	AVERAGE	MFR	MANUFACTURER
B&B	BALLED AND BURLAPPED	MH	MANHOLE
		MIN	MINIMUM
BC	BOTTOM OF CURB	MISC	MISCELLANEOUS
BLDG	BUILDING	MM	MILLIMETRE
BM	BENCHMARK	N	NORTH
BC	BOTTOM OF CURB	NIC	NOT IN CONTRACT
BR	BOTTOM OF RAMP	NO	NUMBER
BS	BOTTOM OF STEP		
BW	BOTTOM OF WALL	NOM	NOMINAL
CAL	CALIPER	NTS	NOT TO SCALE
CB	CATCH BASIN	OC	ON CENTER
CF	CUBIC FEET	OD	OUTSIDE DIAMETER
		PC	POINT OF CURVATURE
CIP	CAST IN PLACE	PE	POLYURETHANE
CL	CENTER LINE	PI	POINT OF INTERSECTION
CLR	CLEARANCE	PL	PROPERTY LINE
CM	CENTIMETER	PT	POINT, POINT OF TANGENCY
CO	CLEAN OUT	PVC	POLYVINYL CHLORIDE
CONT	CONTINUOUS		
CU M	CUBIC METRE	QTY	QUANTITY
DEG	DEGREE	R	RADIUS
DEMO	DEMOLISH, DEMOLITION	REF	REFERENCE
DIA	DIAMETER	REINF	REINFORCE(D)
		REQ'D	REQUIRE(D)
DIM	DIMENSION	REV	REVISION
DTL	DETAIL	ROW	RIGHT OF WAY
DWG	DRAWING	S	SOUTH
E	EAST	SAN	SANITARY
EA	EACH	SD	STORM DRAIN
EL	ELEVATION	SF	
ENG	ENGINEER		SQUARE FOOT (FEET)
EQ	EQUAL	SHT	SHEET
EST	ESTIMATE	SIM	SIMILAR
E.W.	EACH WAY	SPECS	SPECIFICATIONS
EXIST	EXISTING	SQ M	SQUARE METRE
		ST	STORM SEWER
EXP	EXPANSION, EXPOSED	STA	STATION
FFE	FINISHED FLOOR ELEVATION	STD	STANDARD
FG	FINISHED GRADE	SYM	SYMMETRICAL
FL	FLOW LINE	T&B	TOP AND BOTTOM
FOC	FACE OF CURB	TC	TOP OF CURB
FT	FOOT (FEET)	TF	TOP OF FOOTING
FTG	FOOTING	TH	THICK
GA	GAUGE		
GEN	GENERAL	TOPO	TOPOGRAPHY
GR	GRADE ELEVATION	TR	TOP OF RAMP
HORIZ	HORIZONTAL	TS	TOP OF STEP
		TW	TOP OF WALL
HP	HIGH POINT	TYP	TYPICAL
HT	HEIGHT	VAR	VARIES
ID	INSIDE DIAMETER	VOL	VOLUME
INV	INVERT ELEVATION	W	WITH
IN	INCH(ES)	W/O	WITHOUT
INCL	INCLUDE(D)	WT	WEIGHT
JT	JOINT		
LF	LINEAR FEET	WL	WATER LEVEL
LP	LOW POINT	WWF	WELDED WIRE FRAME
LI⁻	LOVV I-OHVI	YD	YARD
		_	A T

#### LINE TYPE LEGEND


Property line
Building Footprint
Extent of Roof / Canopy, above
Extent of Parkade, below
Right of Way
Rain garden - TOP OF POOL
Rain garden - BOTTOM OF POOL
Proposed Contour Line, 0.5m interval
Existing Contour Line, 0.5m interval
Extent of Existing Treeline
SPEA

RAR Setback

#### **UNDERGROUND UTILITIES** (Shown for reference only - refer to Civil Engineer's drawings).


EXISTING		PROPOSED
	Storm Drain	
	Sewer	
	Water	
	Electrical	
	Gas	
	Hydro Tel	

#### **EXISTING TREE LEGEND** (Refer to Arborist Report and Tree Management Plan for full details and

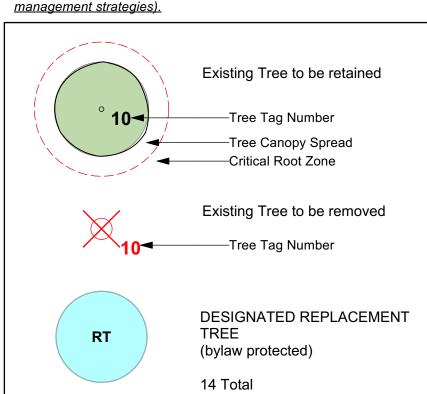


### **GRADING LEGEND**

	Proposed Landscape Grade	
<b>⊕</b> . 17.70	TOW Top of Wall BP Bottom of Pool BW Bottom of Wall TS Top of Stairs TOC Top of Curb BS Bottom of Stairs BC Bottom of Curb HP High Point TP Top of Pool LP Low Point	
17.70 EX	Existing Grade	
16.90 Arch	Architectural grade, for reference only	
<u>17.70</u>	Civil Grade, for reference only	

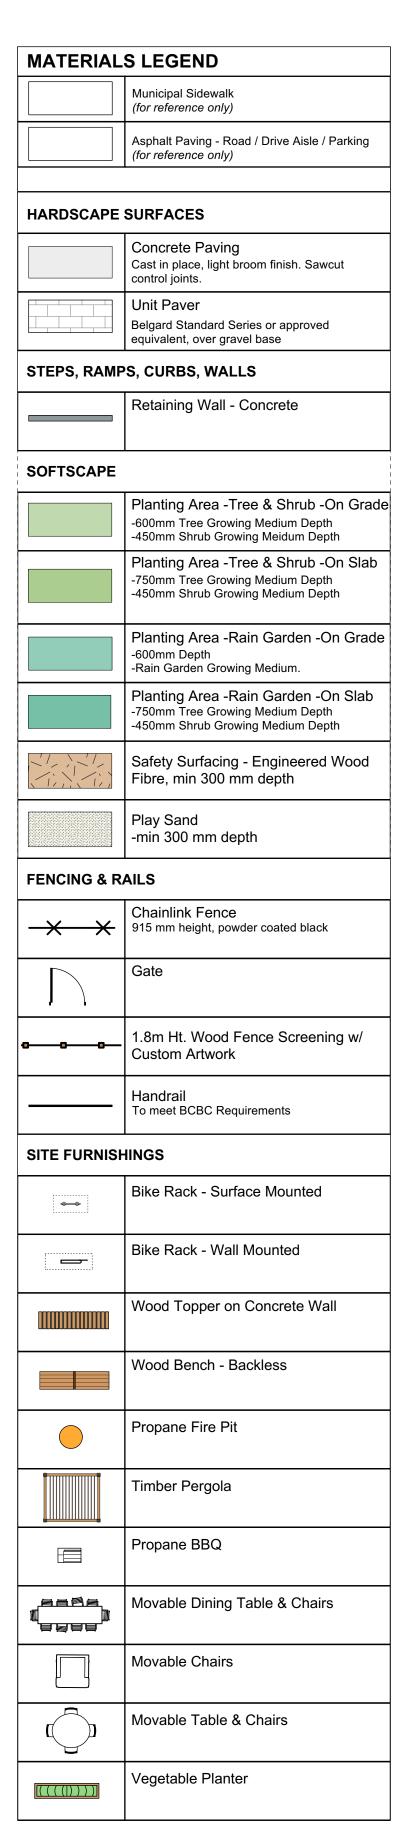



NOT FOR CONSTRUCTION

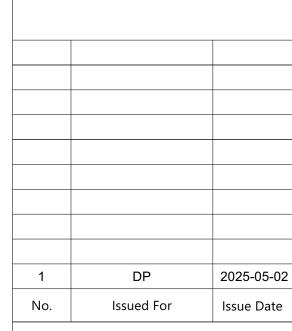



**MNBC Saanich Development** 

3656 RAYMOND STREET & 307 **BRUNSWICK PLACE** Saanich, BC

sheet title

General Information Sheet

124.06 project no. AS SHOWN @ 24"x36" drawn by checked by sheet no.

L0.01

ALL DRAWINGS TO BE READ IN ASSOCIATION WITH CONTRACT SPECIFICATIONS.